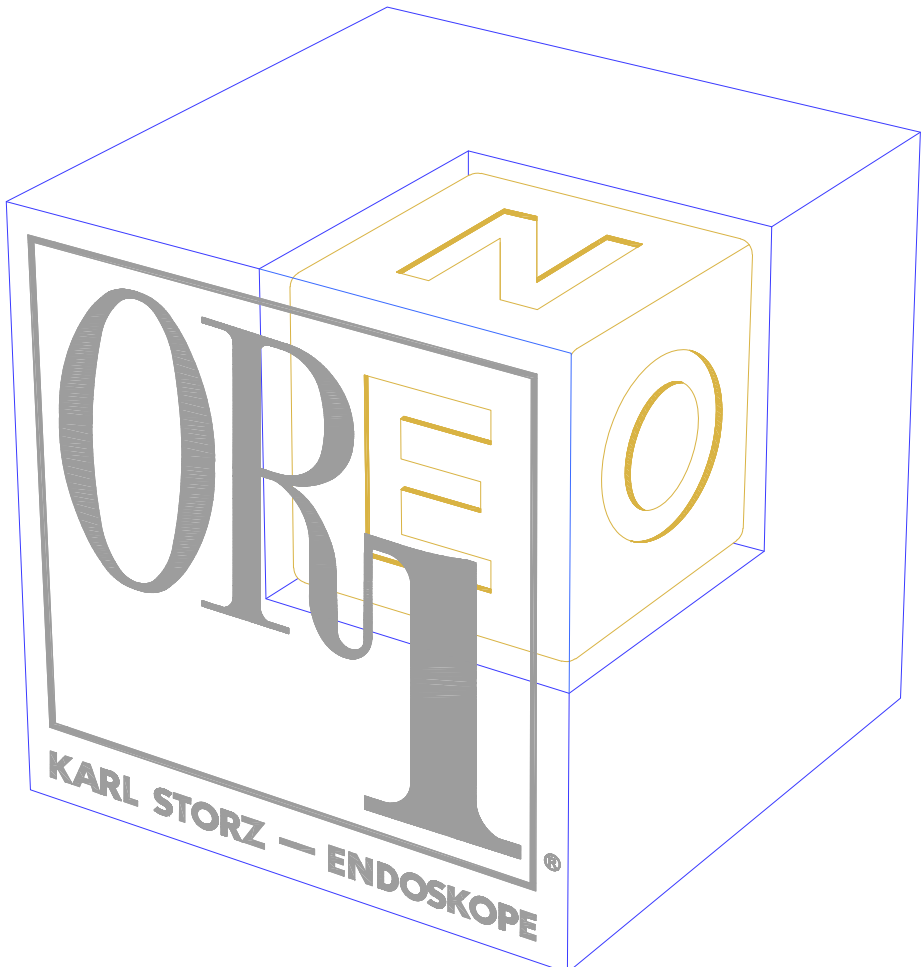

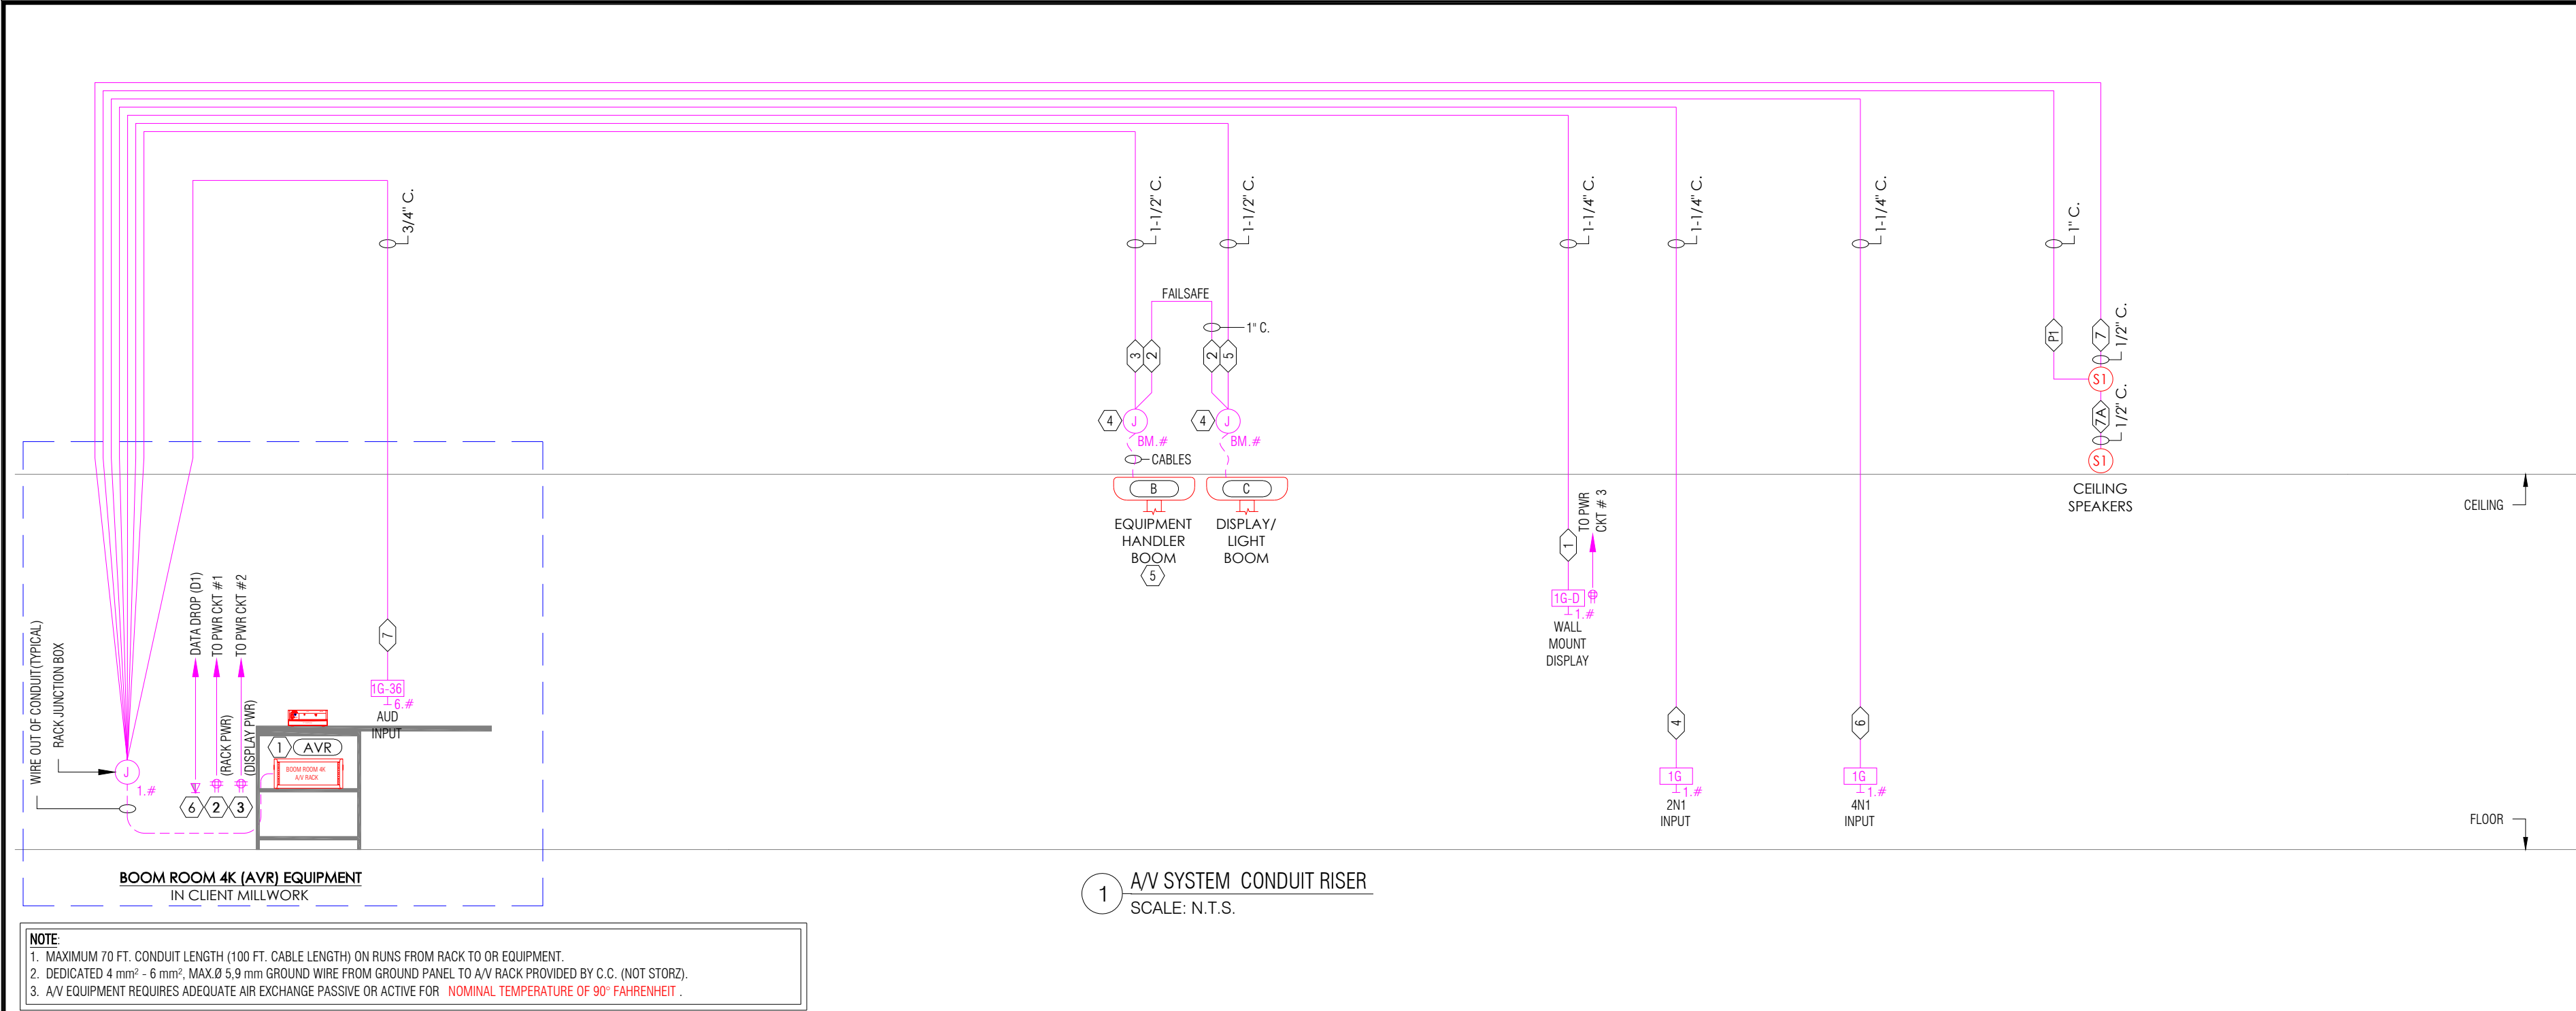


<div>INDEX OF DRAWINGS</div> <div>BR.4K.6.0.0 COVER SHEET BR.4K.6.1.1 LEGENDS, SCHEDULES & RISERS BR.4K.6.2.1 REQUIREMENTS DETAILS #1 BR.4K.6.4.01 FLOOR PLAN & RCP - ROOM NUMBER BR.4K.6.5.01 KSI'S PROJECT MANAGEMENT REQUIREMENTS</div> <div>REVS NOTES: 0. INITIAL RELEASE</div> <div><div>DRAWING ACCEPTANCE SIGN OFF</div><div>Customer or customer's representative has reviewed and approved the drawings which will be used as the basis for the conduit and electrical requirements for installation of the Karl Storz Integration Equipment.</div><div>NAME: _____ SIGNATURE: _____</div><div>TITLE: _____ DATE: _____</div><div>The designs shown on these drawings are planning concept designs only, are not drawn to scale, are not drawn as architectural plans or detailed engineering drawings, do not represent full detail working designs, and do not represent or incorporate detail structural or engineering analysis. These drawings are provided "as-is" and are intended to be used only as planning concept guides, and not for any other purpose. All warranties and representations of any kind, whether expressed, implied or statutory, including warranties of merchant ability and fitness for a particular purpose, with regard to the designs or drawings by a recipient in any manner other than as herein intended. Any recipient of these drawings hereby agrees to indemnify Karl Storz against any and all claims, liability, damages and costs (including attorneys' fees) arising out of, or resulting from, any use of these designs or drawings other than as herein intended.</div></div>	<div>KARL STORZ ENDOSCOPY-AMERICA STAFFORD, TEXAS</div> <div></div> <div>Typical Hospital City, State ROOM NUMBER</div> <div>FACILITY REQUIREMENTS OR1® BOOM ROOM 4K SERIES SYSTEM</div>	<div><div>STORZ KARL STORZ — ENDOSKOPE</div><div>13803 N. PROMENADE STAFFORD, TX 77477-5753 PH. 281.566.4100 FX. 281.566.4109</div><div></div><div>Typical Hospital - City, State OR1® BOOM ROOM 4K SERIES SYSTEM FACILITY REQUIREMENTS: COVER SHEET CONFIDENTIAL - NOT TO BE DISTRIBUTED OUTSIDE OF KSEA, INC. This drawing is the property of KARL STORZ ENDOSCOPY, and is not to be reproduced or copied in whole or in part. It is only to be used for the project and site specifically identified herein and is not to be used on any other project. It is to be returned upon request.</div><div><div>FOR COORDINATION ONLY - NOT FOR CONSTRUCTION</div><table><tr><td>REVISIONS:</td><td>DATE:</td></tr><tr><td>01 REV. 0</td><td>3/31/2022</td></tr><tr><td>(INITIAL RELEASE)</td><td></td></tr><tr><td></td><td></td></tr><tr><td></td><td></td></tr><tr><td></td><td></td></tr><tr><td colspan="2">DRAWN BY: SSatre</td></tr><tr><td colspan="2">ENG. BY:</td></tr><tr><td colspan="2">DATE: 11/6/2020</td></tr><tr><td colspan="2">FILE NAME: 00-BR4K</td></tr><tr><td colspan="2">PLT SC N.T.S</td></tr><tr><td colspan="2">BR4K_20200521</td></tr><tr><td>CHK. BY:</td><td>DATE:</td></tr><tr><td colspan="2">JOB NO.</td></tr><tr><td colspan="2">GENERIC</td></tr><tr><td colspan="2">DRAWING NUMBER</td></tr><tr><td colspan="2">BR.4K. 6.0.0 01 OF 06</td></tr></table></div></div>	REVISIONS:	DATE:	01 REV. 0	3/31/2022	(INITIAL RELEASE)								DRAWN BY: SSatre		ENG. BY:		DATE: 11/6/2020		FILE NAME: 00-BR4K		PLT SC N.T.S		BR4K_20200521		CHK. BY:	DATE:	JOB NO.		GENERIC		DRAWING NUMBER		BR.4K. 6.0.0 01 OF 06	
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JUNCTION BOX SCHEDULE			
J-BOX #	SIZE(MINIMUM)	TYPE (NOTE 1 BELOW)	MOUNTING/COMMENT (NOTE 2 BELOW)
J-1.#	8" X 8" X 4" D (MINIMUM)	NEMA 1, SCREW COVER, EQUAL TO HOFFMAN A-SE SERIES	WALL, FLUSH, SIZE ACCORDING TO CONDUITS REQUIREMENTS
J-BM.#	8" X 8" X 4" D	NEMA 1, SCREW COVER, EQUAL TO HOFFMAN A-SE SERIES	ABOVE CEILING, ADJACENT TO BOOM

JUNCTION BOX SCHEDULE NOTES:

- ALL BOXES AND COVER PLATES ARE PROVIDED BY THE CLIENTS CONTRACTOR UNLESS NOTED OTHERWISE.
- MOUNTING REQUIREMENTS SHOWN ARE THE DEFAULT REQUIREMENTS UNLESS OTHERWISE NOTED/DETAILED.

POWER & HEAT LOAD SCHEDULE						
CIRCUIT REF. #	VOLTS	AMP	DESTINATION	LOAD	ELECT LOAD (WATTS)	HEAT LOAD (BTU)
1	120 VAC	20	RECEPTACLE @ NURSE STATION	A/V RACK(BR4K)	72.25	246.52
2	120 VAC	20	RECEPTACLE @ NURSE STATION	(2)BOOM DISPLAYS	260	887.12
3	120 VAC	20	RECEPTACLES @ WALL DISPLAY(S)	(1)LCD	271	924.65
4	120 VAC	20	RECEPTACLES @ CCU/AIDA (EQUIP BOOM)	CCU/AIDA/PRINTER	898	3063.98

POWER SCHEDULE NOTES:

- ALL A/V POWER CIRCUITS MUST COME FROM THE SAME ELECTRICAL PANEL THAT PROVIDES POWER TO THE PATIENT VICINITY OUTLETS, BOOMS AND SERVICE COLUMNS
- ALL A/V POWER CIRCUITS ARE TO HAVE FULL SIZE DEDICATED NEUTRALS.
- CIRCUITS SHOWN ARE FOR DEDICATED USE WITH STORZ EQUIPMENT ONLY
- A/V CIRCUITS SHALL BE ON THE SAME PHASE AND FEED FROM THE SAME ISOLATED POWER PANEL THAT FEEDS ALL THE PATIENTS CRITICAL EQUIPMENT.
- CIRCUIT BREAKER TRIP CURVE CHARACTERISTICS SHALL BE EQUAL TO OR GREATER THAN SQUARE-D QOB-HM SERIES.

DATA TELECOM SCHEDULE (CLIENT CABLING BY C.C.)			
RUN #	LOCATION	C.C. TO PROVIDE	
D1	DT OUTLET AT AIDA	(2) HOSPITAL NETWORK (FOR STORZ NETWK EQUIP/VIDEO CONF.)	RJ-45

DATA TELECOM SCHEDULE NOTES:

- CONNECTIONS REQUIRED FOR VIDEOCONFERENCING AND/OR VIDEO STREAMING .

SHEET NOTES	
1	A/V EQUIPMENT RACK (AVR): RACK SUPPLIED BY KARL STORZ.
2	RACK POWER RECEPTACLE: LOCATED AT A/V RACK FOR STORZ RACK POWER AND ASSOCIATED AV EQUIPMENT. RACK RECEPTACLE TO BE PROMINENTLY LABELED ' RACK POWER '.
3	DISPLAY POWER RECEPTACLE AT RACK: LOCATED AT RACK FOR BOOM MOUNTED DISPLAYS AND/OR TOUCH PANELS WITH REMOTE 24VDC POWER SUPPLIES. DISPLAY RECEPTACLE SHALL BE PROMINENTLY LABELED ' DISPLAY POWER '.
4	BOOM JUNCTION BOXES: MOUNT ADJACENT TO BOOM SUPPORT STRUCTURE. PROVIDE CEILING ACCESS BELOW BOXES IF CEILING SPACE AT BOX LOCATION IS INACCESSIBLE AFTER FINISHED CEILING IS INSTALLED. SEE BOOM JUNCTION BOX DETAIL.
5	POWER CIRCUITS & RECEPTACLES IN EQUIPMENT HANDLER BOOMS: STORZ EQUIPMENT TYPICALLY REQUIRES (2)20A, 120VAC CIRCUITS WITH (4) RECEPTACLES EACH. SEE BOOM SUPPLIER DRAWINGS FOR ELECTRICAL REQUIREMENTS AT BOOMS.
6	DATA/TELEPHONE BOX: DATA AND TELECOM CONNECTIVITY REQUIRED FOR STORZ INTEGRATION . PROVIDE SUITABLE IDENTIFICATION LABELS. SEE TELECOM/DATA SCHEDULE FOR REQUIREMENTS.

GENERAL NOTES & ABBREVIATIONS	
GENERAL NOTES:	
1. THESE DRAWINGS ARE FOR REQUIREMENTS REFERENCE ONLY. NOT FOR CONSTRUCTION.	
2. SUPPLY AND INSTALLATION OF ALL CONDUIT, POWER CIRCUITS, BACK BOXES, ELECTRICAL DEVICES, ELECTRICAL WIRING IS TO BE PROVIDED BY THE CLIENTS ELECTRICAL CONTRACTOR UNLESS NOTED OTHERWISE.	
3. C.C. TO PROVIDE ADEQUATE VENTILATION FOR NOMINAL A/V EQUIPMENT TEMPERATURE OF 90° FAHRENHEIT.	
GENERAL CONDUIT & BOX NOTES	
1. C.C. TO PROVIDE BLANK COVER PLATES FOR ALL JUNCTION BOXES.	
2. CC. TO PROVIDE CABLE PROTECTION BUSHINGS ON ALL BOXES AND CONDUIT STUB-OUTS.	
3. ALL CONDUIT TO BE MINIMUM 3/4" METALLIC U.N.O.	
4. MAXIMUM LENGTH FOR FLEX CONDUIT IF USED FOR STORZ A/V CABLING IS 25 FEET.	
5. EXTRA PULL BOX IS REQUIRED AFTER BENDS TOTAL 270°	
6. CONDUITS TO BE DE-BURRED, CLEANED, CAPPED, AND FURNISHED WITH NYLON PULL ROPE.	
7. CONDUIT STUB-OUTS, JUNCTION BOXES, AND OUTLETS SHALL BE SUITABLY LABELED FOR IDENTIFICATION OF FUNCTION, J-BOX #, AND/OR CONDUIT NUMBER.	
ABBREVIATIONS:	
A.F.F. = ABOVE FINISHED FLOOR	NSE = NURSE STATION EQUIPMENT
A/R = AS REQUIRED	NSTP = NURSE STATION TOUCH PANEL
B.C.P. = BLANK COVER PLATE	N/A = NOT APPLICABLE
B.F.C. = BELOW FINISHED CEILING	N/R = NOT REQUIRED
C.C. = CLIENTS CONTRACTOR (NOT BY KARL STORZ)	N/U = NOT USED
C.P. = COVER PLATE	O.R. = OPERATING ROOM
CRE = CONTROL ROOM EQUIPMENT	RJB = RACK JUNCTION BOX
HT. = HEIGHT	S.F. = STERILE FIELD
I.G. - ISOLATED GROUND (TECHNICAL GROUND)	T.B.D. = TO BE DETERMINED
I.P. = ISOLATED PWR. (UNGROUND NEUTRAL PWR)	U.N.O. = UNLESS NOTED OTHERWISE

SYMBOL LEGEND			
SYMBOL	DESCRIPTION	BOX (NOTE 1 BELOW)	MOUNTING/COMMENT
[AP]	CEILING ACCESS PANEL	(NOTE 3 BELOW)	FOR REQUIRED ACCESS TO BOXES ABOVE CLG.
[#]	EQUIPMENT LABEL		DENOTES EQUIPMENT AT LOCATION SHOWN
[<#]	CONDUIT OR CABLE RUN #		CONDUIT/CABLE RUN REFERENCE #
[—]	CONDUIT STUB OUT		CONDUIT STUB OUT WITH BUSHING
[J]	JUNCTION BOX	SEE J-BOX SCHEDULE	SEE J-BOX SCHEDULE
[1G]	A/V IN/OUTPUT WALL BOX	4S, TR-1G, 1G-B.C.P.	WALL, FLUSH, RECEPTACLE HT., SEE 2/AV.IP.6.2.1
[1G-36]	A/V IN/OUTPUT WALL BOX	4S, TR-1G, 1G-B.C.P.	WALL, FLUSH, 36" A.F.F. HT., SEE 2/AV.IP.6.2.1
[1G-D]	A/V WALL DISPLAY WALL BOX	4S, TR-1G, 1G-B.C.P.	WALL, FLUSH, SEE 25/AV.IP.6.2.1
[S1]	CEILING SPEAKER, TYPE 1	BACK CAN SUPPLIED BY STORZ	CEILING, FLUSH, MOUNTED BY C.C. (NOTE 9)
[⊖]	DUPLEX POWER RECEPTACLE	A/R, TYPICAL 1G	WALL, FLUSH, RECEPTACLE HT.
[⊕]	QUAD POWER RECEPTACLE	A/R, TYPICAL 2G	WALL, FLUSH, RECEPTACLE HT.
[▷]	DATA/TELEPHONE BOX	A/R, TYPICAL 1G	WALL, FLUSH, RECEPTACLE HT. (NOTE 6)

SYMBOL LEGEND NOTES	
1. ALL BOXES AND COVER PLATES ARE PROVIDED BY THE CLIENTS CONTRACTOR UNLESS NOTED OTHERWISE.	
2. MOUNTING REQUIREMENTS SHOWN ARE THE DEFAULT REQUIREMENTS UNLESS OTHERWISE NOTED/DETAILED.	
3. BOXES/OUTLETS/RECEPTACLES LOCATED ABOVE THE CEILING MUST BE WITHIN 18 INCHES OF THE CEILING AND BE ACCESSIBLE FROM THE SPACE BELOW. CLIENT / C.C. TO PROVIDE SUITABLE CEILING ACCESS PANELS AT DEVICE LOCATIONS. (ACCESS PANELS EQUAL TO WILLIAMS BROS. MODEL WBFRC).	
4. "RECEPTACLE HEIGHT" DENOTES MOUNTING HEIGHT OF REGULAR RECEPTACLES SPECIFIED FOR THIS PROJECT.	
5. "SWITCH HEIGHT" DENOTES MOUNTING HEIGHT OF REGULAR SWITCHES SPECIFIED FOR THIS PROJECT.	
6. SEE DATA/TELECOM SCHEDULE FOR CLIENT CABLING REQUIREMENTS.	
7. SEE STORZ STREAMCONNECT SYSTEM REQUIREMENTS FOR CLIENT REQUIREMENTS.	
8. SEE STORZ CompleteView SYSTEM REQUIREMENTS FOR CLIENT REQUIREMENTS.	
9. C.C. TO SUSPEND SPEAKER ASSEMBLY FROM STRUCTURE ABOVE CEILING.	
10. BOX/OUTLET NUMBER: "1.#" FIRST NUMBER DENOTES BOX/OUTLET NUMBER. "#" DENOTES ROOM SEQUENCE.	
BOX TYPES:	
1G = SINGLE GANG METALLIC BACK BOX (MINIMUM DEPTH 3-1/2").	
2G = 2 GANG METALLIC BACK BOX (MINIMUM DEPTH 3-1/2").	
4G = 4 GANG METALLIC BACK BOX (MINIMUM DEPTH 3-1/2").	
4S = 4" X 4" SQUARE BACK BOX WITH TRIM RING AS NOTED (MINIMUM DEPTH 3-1/2").	
TR-1G = TRIM RING FOR MOUNTING 1 GANG PLATE.	
TR-2G = TRIM RING FOR MOUNTING 2 GANG PLATE.	
#G-B.C.P. = BLANK COVER PLATE, METALLIC, GANG SIZE AS DENOTED BY #.	

STORZ
KARL STORZ – ENDOSKOPE

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CONDUIT AS SCHEDULED

1 DETAIL - BOOM JUNCTION BOX
SCALE: N.T.S

4S (4" X 4") BACKBOX
TR-1G TRIM RING- 1 GANG
1G-BCP 1 GANG- BLANK COVER PLATE

2 DETAIL - 4S BOX WITH 1G TRIM RING
SCALE: N.T.S

4S (4" X 4") BACKBOX
TR-2G TRIM RING- 2 GANG
2G-BCP 2 GANG- BLANK COVER PLATE

3 DETAIL - 4S BOX WITH 2G TRIM RING
SCALE: N.T.S

LV-TR-1G LOW VOLTAGE TRIM RING
1G-BCP 1 GANG- BLANK COVER PLATE

4 DETAIL - LV TRIM RING AND PLATE
SCALE: N.T.S

LOCATE DATA DROP INSIDE J1 IF POSSIBLE.

5 DETAIL - RACK J-BX ELEVATION (TYP.)
SCALE: N.T.S

SPEAKER AND GRILLE (PROVIDED AND INSTALLED BY STORZ)

6 DETAIL - CLG. SPEAKER (POWERED)
SCALE: N.T.S

CEILING

7 DETAIL - TOMS CAMERA
SCALE: N.T.S

DISP 32" (TM343) DISPLAY
DISPLAY WT.: 29.1 LBS(34.6 lbs with bracket & decoder)
MAX. PWR: 167 W (39W Power Save Mode)
HEAT LOAD: 569.8 BTU/hr

8 DETAIL - 32" (TM343) BOOM DISPLAY
SCALE: N.T.S

PWR TM343 POWER SUPPLY
HEAT LOAD: 167W - 569.8 BTU/hr

9 DETAIL - TM343 DISPLAY PWR SUPPLY
SCALE: N.T.S

DISP 27" DISPLAY
DISPLAY WT.: 20.28 LBS(25.6 lbs with bracket & decoder)
MAX. PWR: 100 W
HEAT LOAD: 341.2 BTU

10 DETAIL - 27" BOOM DISPLAY
SCALE: N.T.S

PWR BOOM DISPLAY POWER SUPPLY (CLASS 1)
HEAT LOAD: 100W - 341.2 BTU/hr

11 DETAIL - PWR SPLY, 24V, 5A, 4 PIN DIN
SCALE: N.T.S

AIDA IMAGE CAPTURE
MAX. WT. (LOADED) : 28 LBS
MAX. PWR: 508 W
HEAT LOAD: 1733 BTU

12 DETAIL - AIDA BELLA
SCALE: N.T.S

APTR AIDA PRINTER
MAX. WT. (LOADED) : 25.3 LBS
MAX. PWR: 340 W
HEAT LOAD: 1160 BTU

13 DETAIL - AIDA PRINT (SONY)
SCALE: N.T.S

AVR A/V RACK (BR4K)
MAX. WT. (LOADED) : 23 LBS
MAX. PWR: 72.25 W
HEAT LOAD: 246.37 BTU/hr

14 DETAIL - BOOM ROOM 4K (AVR)
SCALE: N.T.S

CONV CONVERTER
MAX. WT.: 0.5 LBS
HEAT LOAD: 8.5 BTU/hr
DEPTH: 0.9"

14 DETAIL - HDMI/3G-SDI BI-DIRECT
SCALE: N.T.S

ENC EN/DECODER
MAX. WT.: 7 LBS
HEAT LOAD: 82 BTU/hr

15 DETAIL - HDMI/DisplayPort Decoder
SCALE: N.T.S

ENC EN/DECODER
MAX. WT.: 1.4 lbs
HEAT LOAD: 44.2 BTU (ENCODER/DECODER)

16 DETAIL - 10G Encoders/Decoders
SCALE: N.T.S

CONV CONVERTER
MAX. WT.: 0.5 LBS
HEAT LOAD: 30 BTU/hr

17 DETAIL - HDMI/SDI 4K CONVERTER
SCALE: N.T.S

TX/RX TRANSMIT/RECEIVER
HEAT LOAD: 2.5W - 8.5 BTU/hr

18 DETAIL - FIBER 18G/4K HDMI
SCALE: N.T.S

CONV CONVERTER
MAX. WT.: 0.6 LBS
HEAT LOAD: 40.92 BTU/hr

19 DETAIL - SDI to HDMI CONVERTER
SCALE: N.T.S

MFS MFS DVI SCALER
MAX. WT.: 7 LBS
MAX. PWR: 24 W
HEAT LOAD: 81.84 BTU/hr

20 DETAIL - MFS DVI SCALER
SCALE: N.T.S

DA Distribution Amplifier
MAX. WT.: 0.7 LBS
HEAT LOAD: 10.2 BTU/hr

21 DETAIL - DISPRIBUTION AMPLIFIER
SCALE: N.T.S

CONV CONVERTER
MAX. WT.: 0.6 LBS
HEAT LOAD: 40.92 BTU/hr

22 DETAIL - SDI TRANSPORT CONV
SCALE: N.T.S

WMR WIRELESS MIC REC
MAX. WT.: 10.1 oz
MAX. PWR: 55 W
HEAT LOAD: 1.9 BTU

23 DETAIL - WIRELESS MIC RECEIVER
SCALE: N.T.S

MVC Mixer/Volume Controller
WT.: 0.6 LBS
HEAT LOAD: 16.7 BTU/hr

24 DETAIL - AUDIO PROCESSOR
SCALE: N.T.S

DA Distribution Amplifier
MAX. WT.: 0.7 LBS
HEAT LOAD: 10.2 BTU/hr

21 DETAIL - DISPRIBUTION AMPLIFIER
SCALE: N.T.S

CONV CONVERTER
MAX. WT.: 0.6 LBS
HEAT LOAD: 40.92 BTU/hr

22 DETAIL - SDI TRANSPORT CONV
SCALE: N.T.S

WMR WIRELESS MIC REC
MAX. WT.: 10.1 oz
MAX. PWR: 55 W
HEAT LOAD: 1.9 BTU

23 DETAIL - WIRELESS MIC RECEIVER
SCALE: N.T.S

MVC Mixer/Volume Controller
WT.: 0.6 LBS
HEAT LOAD: 16.7 BTU/hr

24 DETAIL - AUDIO PROCESSOR
SCALE: N.T.S

25 DETAIL - WALL MOUNTED LED DISPLAY
SCALE: N.T.S

26 DETAIL - STORZ IMAGE 1 S
SCALE: N.T.S

27 DETAIL - 4N1 WALL PLATE
SCALE: N.T.S

28 DETAIL - 2N1 WALL PLATE
SCALE: N.T.S

29 DETAIL - AUDIO INPUT/VOLUME PLATE
SCALE: N.T.S

30 DETAIL - BLUETOOTH IN WALL RECEIVER
SCALE: N.T.S

WARNING:
A/V EQUIPMENT REQUIRES ADEQUATE AIR EXCHANGE PASSIVE OR ACTIVE FOR NOMINAL TEMPERATURE OF 90° FAHRENHEIT.

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JOB NO.	GENERIC
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03 OF 06	

NOT SHOWN

1 OVERALL FLOOR PLAN - PARTIAL
SCALE: 1/8" = 1'-0"
BACKGROUND REF.: *.DWG RECEIVED 00/00/2020



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FACILITY REQUIREMENTS:
OVERALL FLOOR PLAN - Partial

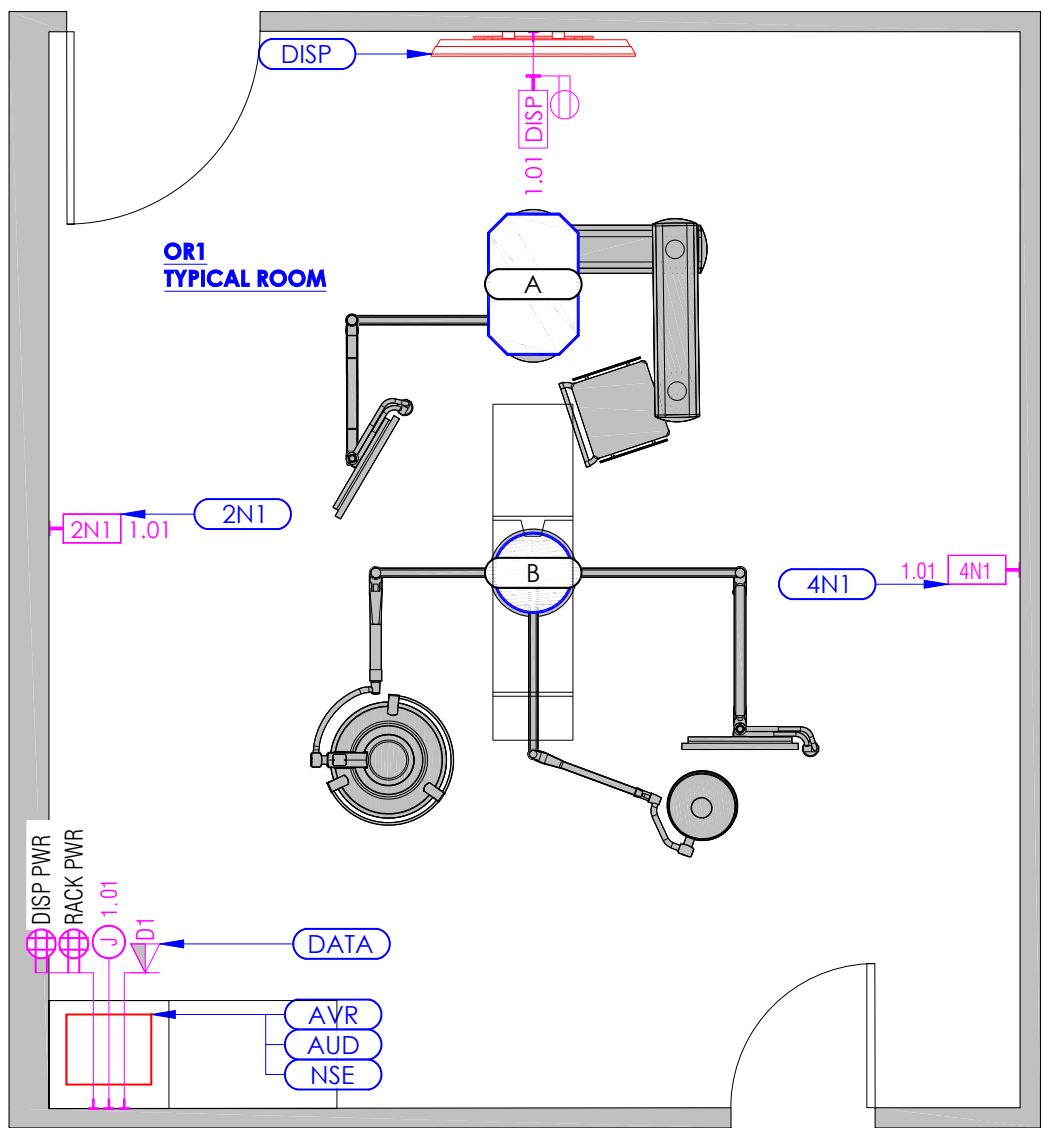
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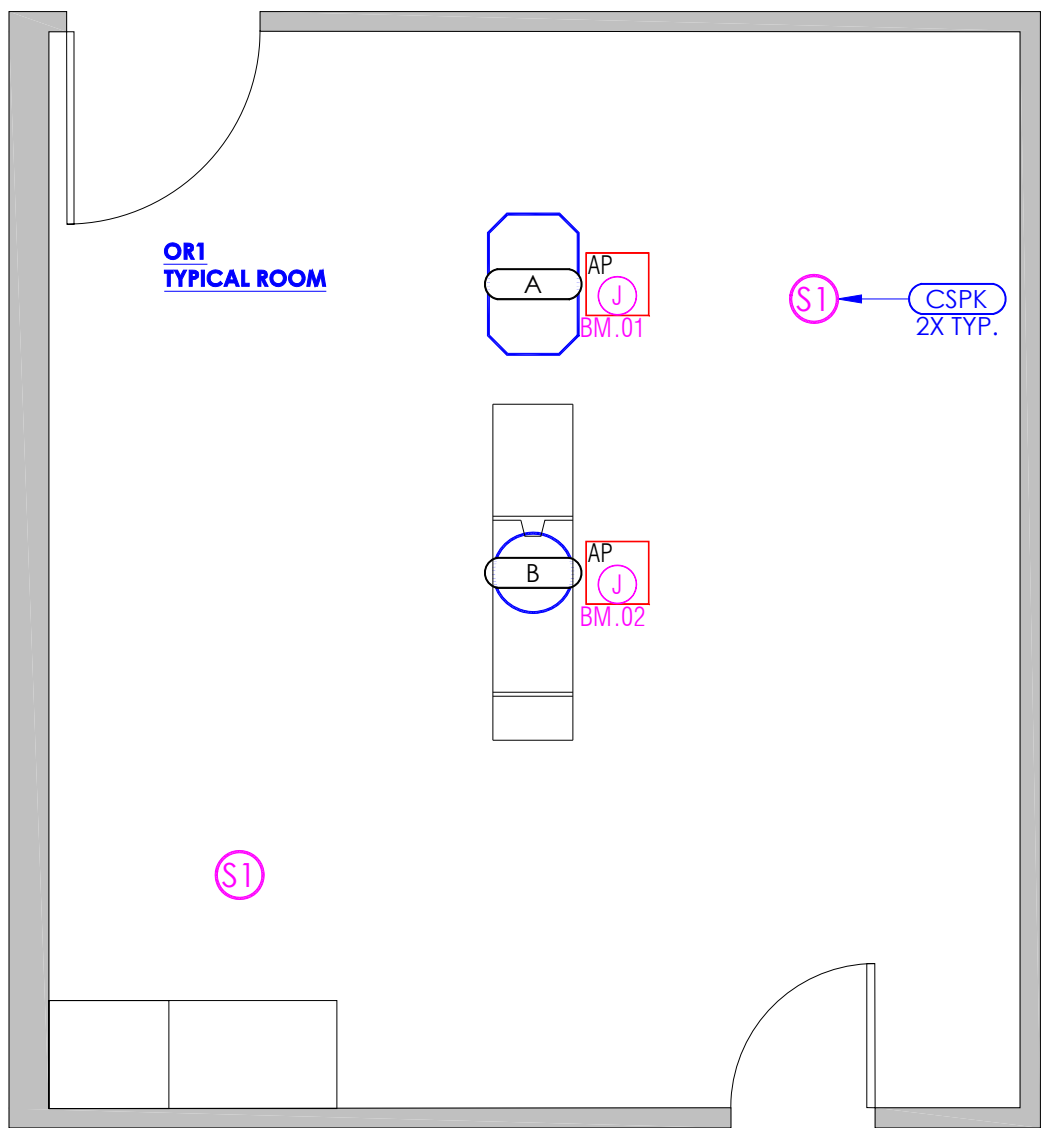
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1 FLOOR PLAN - ROOM NUMBER
SCALE: N.T.S
BACKGROUND REF.: *.DWG RECEIVED 00/00/2020



2 REFLECTED CEILING PLAN - ROOM NUMBER
SCALE: N.T.S
BACKGROUND REF.: *.DWG RECEIVED 00/00/2020

A/V EQUIPMENT SCHEDULE			
SYMBOL	LOCATION/DEVICE	EQUIPMENT BY STORZ	EQUIPMENT BY OTHERS
2N1	WALL MOUNTED	(1) AUX INPUT 2N1(DisplayPort/HDMI) PLATE	
4N1	WALL MOUNTED	(1) AUX INPUT 4N1(CV/SV/VGA/DVI) PLATE	
A	EQUIPMENT BOOM (STORZ EQUIPMENT)	(1) STORZ CCU INPUT PLATE, (1) AUX INPUT (CV/SV/SDI) PLATE, (1) 27" FLAT PANEL DISPLAY	DISPLAY MOUNT
B	DISPLAY/LIGHT BOOM	(1) 27" FLAT PANEL DISPLAY	DISPLAY MOUNT/SURGICAL LIGHT
AVR	4K VIDEO PROCESSOR	(1) 4K VIDEO PROCESSOR, (2)FLAT PANEL DISPLAY POWER SUPPLIES	
NSE	NURSE'S STATION EQUIPMENT CABINET	(1) AIDA (RECORDING DEVICE), (1) MEDICAL PRINTER (1) LOCAL COMPUTER INPUT,	HIS COMPUTER
AUD	NURSE STATION	(1) MP3 AUDIO INPUT	
CSPK	CEILING MOUNTED	(4) CEILING SPEAKERS & BACKBOXES	BACKBOX MOUNTING
DISP	WALL MOUNTED	(FOR DATA TELECOM CONNECTION)	SEE DATA / TELECOM SCHEDULE
DAT	WALL MOUNTED	(1) LARGE FORMAT FLAT PANEL DISPLAY	BRACKET ANCHORAGE BY C.C. (NOT STORZ)
A/V EQUIPMENT SCHEDULE NOTES: 1. EQUIPMENT LISTED IS FOR COORDINATION PURPOSES ONLY. (BASED ON STORZ'S UNDERSTANDING OF EQUIPMENT & LOCATIONS). REFER TO CONTRACT SPECIFICATIONS FOR ACTUAL REQUIREMENTS.			

STORZ
KARL STORZ—ENDOSKOPE

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Typical Hospital - City, State

OR1® BOOM ROOM 4K SERIES SYSTEM

FACILITY REQUIREMENTS:

FLOOR PLAN & RCP - ROOM NUMBER

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JOB NO.	
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6.4.01	
05 OF 06	



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Typical Hospital - City, State

OR1® BOOM ROOM 4K SERIES SYSTEM

FACILITY REQUIREMENTS:

KXSIS PROJECT MANAGEMENT REQUIREMENTS

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JOB NO.
GENERIC

DRAWING NUMBER
**BR.4K.
6.5.01
06 OF 06**

KARL STORZ SITE READINESS CHECKLIST

OVERALL SITE STATE:

Upon KARL STORZ'S arrival at the facility, the site must be clean with all site prep work completed, the boom equipment installed, and the nurse station millwork complete. All owner furnished equipment must be available for installation and testing.

Although other trades may work in the same space, priority must be given to the floor space requirements of staging equipment and materials and the ability of the crew to maintain their workflow.

GENERAL SITE PREP WORK:

- ☐ All required conduits must be marked and installed with pull strings.
- ☐ All facility provided network cables must be installed and tested.
- ☐ All electrical outlets on equipment handlers, nurse millwork and a/v rack location must have power.
- ☐ Permanent power must be energized.
- ☐ Ceiling speaker cutouts must be prepared.
- ☐ Wall mounts for flat panel displays and touch panels must be installed.
- ☐ All network data drops need to be installed.

MILLWORK:

- ☐ Millwork must be installed with proper venting for calculated heat loads per the KARL STORZ drawings.
- ☐ Cover plate of large junction box behind av rack has mouse hole cut in proper location.
- ☐ Facility provided carpenter must be available for any grommet placement.

BOOM EQUIPMENT:

- ☐ Boom equipment must be installed and available for cabling by the KARL STORZ team.
- ☐ Boom equipment must be powered.
- ☐ In-Light Camera boxes must be available.

OWNER FURNISHED EQUIPMENT:

- ☐ OR equipment such as C-ARMS, Ultrasound, CT Machines and Microscopes must be available for testing and integration.
- ☐ Computers and workstations must be available for cable integration and testing.
- ☐ Videoconference telephone or network connections must be live.
- ☐ If applicable, all lighting control equipment must be installed and tested by the facility.

ENVIRONMENTAL CONDITIONS:

- ☐ Site is safe to work.
- ☐ If site has specific attire requirements and/or PPE requirements, the customer must provide access to appropriate attire and PPE for the crew.
- ☐ The OR must be clean and dust free.
- ☐ Delivery access must be available.
- ☐ Area to store all KARL STORZ materials for duration of installation identified.
- ☐ Trash disposal must be available.
- ☐ All safety training must be scheduled prior to arrival.
- ☐ Any sub-contractor conflicts need to be addressed and conflicting schedules need to be addressed to minimize KARL STORZ downtime.
- ☐ Adequate working hours must be available to the product deployment crew.

Use this document to ensure that all teams and spaces are aligned for the deployment of your KARL STORZ integrated operating room. Failure to meet readiness can impact your installation schedule.

Thank you for your partnership,
KARL STORZ

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